




This is the design for Dharamsing's new home, which you can see him and his wife standing outside on your envelope.

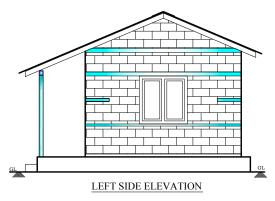

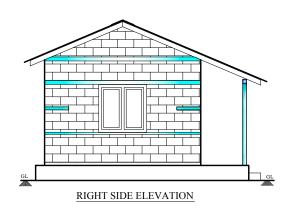

The weather resistant roof, made of corrugated galvanised iron and costing \$297, is strong enough to keep out the monsoon rains. —

Each house has four windows, costing £30.19 each. Anything you can give will help give our veterans the new homes they deserve.

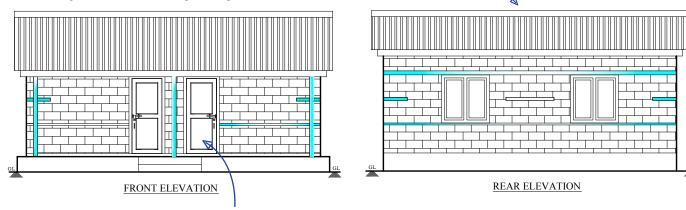

Opening schedule:

Ser.	Description	Size	Qty	Unit	
1	Door - D	3'-0''x6'-6''	2	Nos	
2	Window - W	4'-0''x4'-0''	4	Nos	

Note:

- 1. Dressed stone masonry wall footing with mud mortar.
- 2. Dressed stone masonry load bearing wall with mud mortar.
- 3. Timber door, window, truss and purlin.
- 4. Cement plaster on floor and walls surface.
- 5. Heavy guage CGI sheet roofing.
- 6. Ready made enamel painting on door window.
- 7. RCC bands with vertical bar at corner and T-junction.

The sturdy timber doors, at a cost of £58.19 per house, will give our pensioners security and help reinforce the walls.



GWT

EARTHQUAKE RESPONSE TEAM (EQRT)

P.O. BOX - 50, POKHARA, NEPAL

TEL: 061 - 567329 FAX: 061 - 440630 ROJECT:

WITH CGI PITCH ROOF


STONE MASONRY LOAD BEARING WALL


TITLE: GROUND FLOOR PLAN &

ELEVATION


		DRAWING NO.	A-02	DESIG DRAW
I		PROJECT NO.		CHEC
I		SCALE	1"=8'-0"	APPRO
I		DRAWN DATE	18 NOV 2015	ISSUE


DESIGNED/ DRAWN BY	THAL RANA
CHECKED BY	
APPROVED BY	
ISSUE DATE	

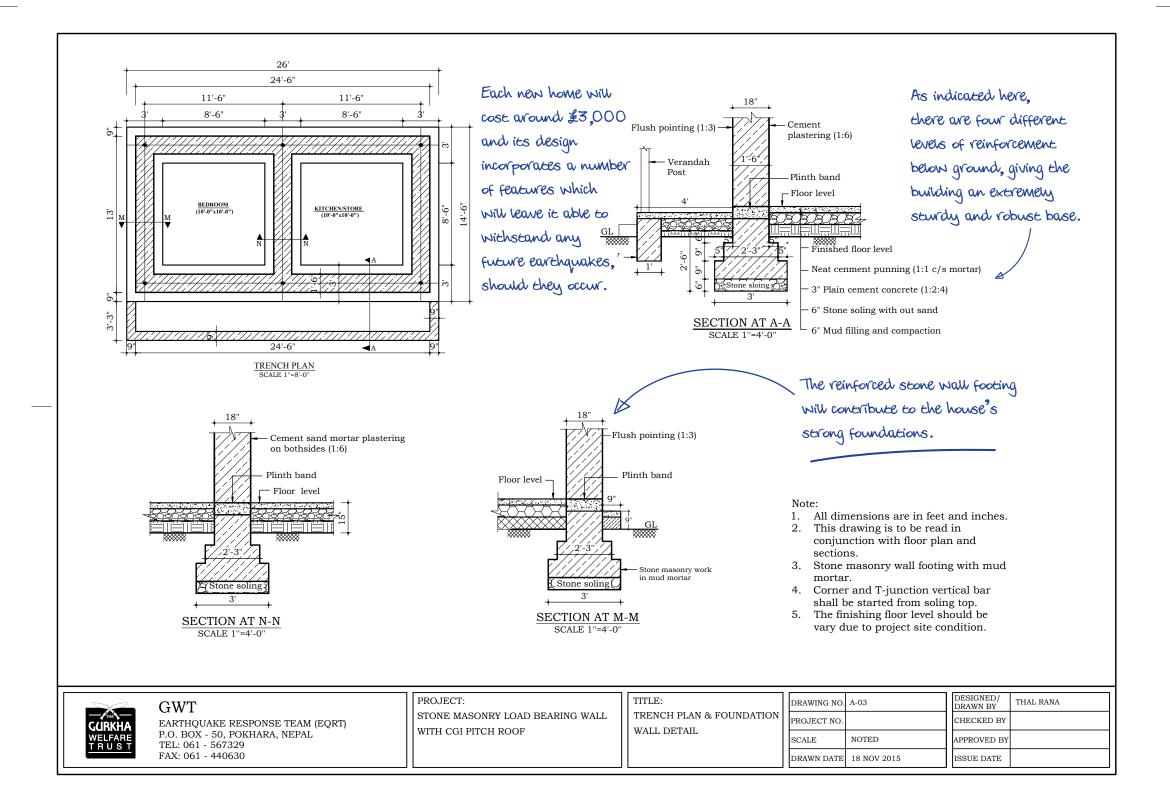

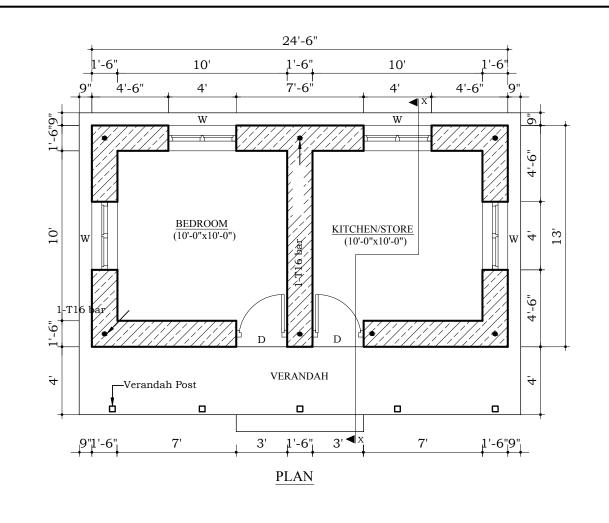


This is the design for Dharamsing's new home, which you can see him and his wife standing outside on your envelope.

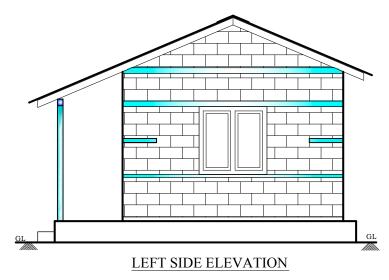


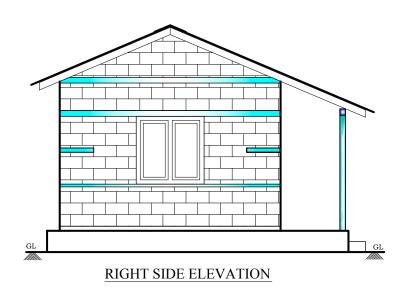

Each new home will cost around £3,000 and its design incorporates a number of features which will leave it able to withstand any future earthquakes, should they occur.

The weather resistant roof, made of corrugated galvanised iron and costing 297, is strong enough to keep out the Monsoon rains.

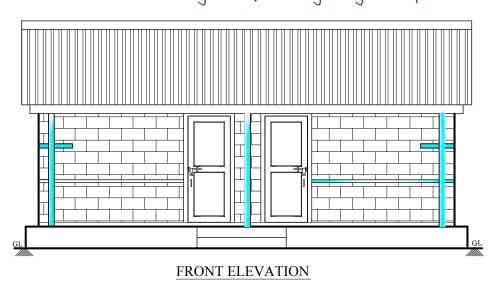

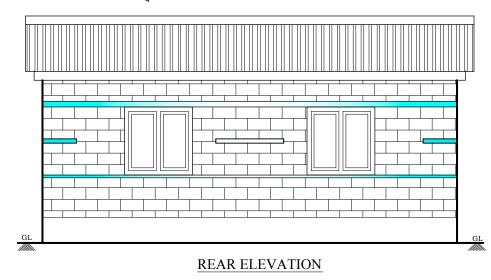

Opening schedule:

Ser.	Description	Size	Qty	Unit
1	Door - D	3'-0''x6'-6''	2	Nos
2	Window - W	4'-0''x4'-0''	4	Nos

Note:

- 1. Dressed stone masonry wall footing with mud mortar.
- 2. Dressed stone masonry load bearing wall with mud mortar.
- 3. Timber door, window, truss and purlin.
- 4. Cement plaster on floor and walls surface.
- 5. Heavy guage CGI sheet roofing.
- 6. Ready made enamel painting on door window.
- 7. RCC bands with vertical bar at corner and T-junction.



GWT

EARTHQUAKE RESPONSE TEAM (EQRT)

P.O. BOX - 50, POKHARA, NEPAL TEL: 061 - 567329

FAX: 061 - 440630

PROJECT:

STONE MASONRY LOAD BEARING WALL WITH CGI PITCH ROOF

TITLE:

GROUND FLOOR PLAN & ELEVATION

DRAWING NO.	A-02	DES DRA	
PROJECT NO.		СНІ	
SCALE	1''=8'-0''	APP	
DRAWN DATE	18 NOV 2015	ISS	

DESIGNED/ DRAWN BY	THAL RANA
CHECKED BY	
APPROVED BY	
ISSUE DATE	

